\$540,000



Lot 35 The Link, Rolleston



For Sale

House and Land Package

	Dwelling Size	Section Size				
-	173m²	450m²	3	1	2	2

With reserve outlook this home features three bedrooms, master with ensuite and walk-in robe, open plan living, dining and kitchen with walk-in pantry, family bathroom and internal access double garaging. Well appointed for the sun on an easy care landscaped section, offering quality fixtures and fittings throughout and finished to a high standard.

Just twenty minutes from Christchurch, Rolleston has so much to offer. You are spoilt for choice within New Zealand's fasting growing area. Offering retailers, eateries, parks and reserves along with a newly established primary school and Rolleston college in close proximity. Only for a short drive to central Rolleston with a shopping complex to cater all requirements.

Lot 35 The Link, Rolleston



Quality cladding selections Metal pressed tile roof 2.42m ceiling height


1.98m internal door height Windsor door hardware Designer kitchen

Bosch appliances Italian tapware LED light fittings


Norman Ellison carpets 8.0kw heatpump Fully landscaped

Reserve outlook After care service 10 year Master Build guarantee

Floor Plan:

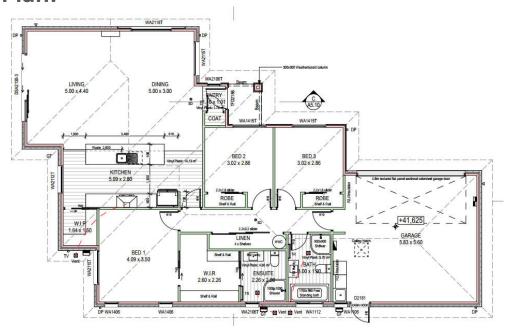

Location:

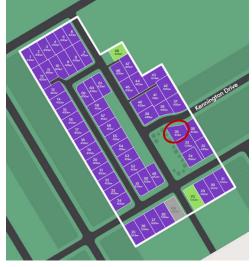

Disclaimer: This material is for the use of illustrative and guidance purposes. All efforts have been made by Stonewood Homes Christchurch to ensure the information correctly illustrates the dwelling however Stonewood Homes accept no responsibility for any variances which maybe become apparent once the build commences.

Specification

Lot 35 The Link, Rolleston



GENERAL

Guarantee: 10 year Master Build guarantee

Warranty: 365 day warranty period

Insurance: Builders risk insurance

STRUCTURE

Foundation/floor slab: TC1 RibRaft

Framing: 2.42m NZ5S 3602:2003 with building wrap – 90mm LVL

Trusses: Kiln dried pine

Cladding (main): Brick – Austral 70 series – Origin series

Cladding (feature): James Hardie linea

ROOFING

Roof: 25° Gerard metal pressed tile—Corona Shake

Downpipes: Colorsteel rectangular 75x55mm

Fascia and gutter: Dimond metal fascia and quad gutter

WINDOWS AND DOORS

Entry door: APL 860mm Latitude with urbo lever

Windows: Vantage aluminium joinery with grey tint and urbo hardware

Garage door: Coloursteel flat panel woodgrain 4.8m

Internal doors: 1980mm Straten (horizontal V groove polycore)

Wardrobe doors: Horizontal V groove

Window coverings: Excluded

INTERIOR LINING

Insulation: R2.4 wall batts, R4.0 ceiling batts excluding garage

Plasterboard: GIB board - 10mm to walls, aqualine to bathrooms and 13mm to ceilings

Gib stopping: Grade 4 paint finish in accordance with AS/NZ 2311:2009

Gib external corners: Gib square stop
Painting: Resene Zylone
Soffit linings: Hardiflex 4.5mm

INTERIOR JOINERY

Internal door hardware: Windsor Futura – Apex brushed nickel

Skirting: 60mm bevel

Wardrobe shelving: MDF shelf and rail
Cupboard shelving: MDF shelves x4

Specification

Lot 35 The Link, Rolleston



KITCHEN AND LAUNDRY

Kitchen joinery: As per plan

Tapware: Paffoni Ringo—Black

Oven: Bosch HBF133BSOA – stainless steel oven

Hob: Bosch PKE611K17A – ceramic cooktop

Dishwasher: Bosch SMU50E75AU – stainless steel dishwasher

Rangehood: Bosch DWB97DM50A—canopy rangehood

Laundry joinery: Raymor supertub

FLOORING

Carpet: Norman Ellison

Vinyl planking: Karndean Knightplank

ELECTRICAL

Plugs / Light Fittings: As per plan

Heatpump: Fujitsu 8.0kw ASTG24LFCC

BATHROOMS AND PLUMBING

Vanities: Raymor armada—white

Mirrors: Polished edge

Toilets: Englefield Evora with standard seat

Showers: Arena curved with moulded wall

Bath: Newtech Indus back-to-wall freestanding bath

Tapware: Paffoni Blu BLU071

Shower slides: Paffoni Brio ZSAL194CR

Towel rails: Newtech 5 ladder square heated towel rail

Extractors: Weiss Clearflow FV160

Hot water cylinder: Rheem 250L

Exterior taps: 2

LANDSCAPING

Driveway and patio: Exposed aggregate

Vehicle crossing: Included

Soft landscaping: Lawn and planting to street frontage

Fencing: 1.8m timber paling to boundary to left and rear boundary, pool style fenc-

ing to right boundary. Internal fencing and one gate to meet developers

requirements.


Letterbox and clothesline: Urban box on post / Sun King folding frame

Pictorial

Lot 35 The Link, Rolleston



Roof profile

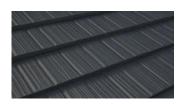

Internal doors



Internal door hardware



Front door



Window hardware

Oven



Garage door profile

Ceramic cooktop



Rangehood



Dishwasher



Vanities



Kitchen tapware



Towel rail



Showers



Bath



Basin mixers



Shower slides



Shower / bath mixers



Toilet



Towel rail









Colour Scheme

Lot 35 The Link, Rolleston



EXTERIOR

Roof: Obsidian

Fascia / Gutter / Downpipes: Ebony

Window joinery: Ebony

Front door: Ebony

Front door frame: Ebony

Garage door: Ebony

Garage door frame: Ebony

Soffits: Resene half black white

Exterior cladding (main): Alpine with ivory mortar

Exterior cladding (feature): Resene All Black

INTERIOR

Ceilings: Resene half black white

Walls: Resene black white

Interior doors: Resene black white

Skirting: Resene black white

Carpet: Dalton - Woodland

Vinyl plank: Pale limed oak

Kitchen cabinetry: Melteca - Bullet pearl. Floating

shelves in classic oak.

Kitchen benchtop: TriStone 12mm – Pure white with

negative detail. Black sink with drain-

er.

Tiles (kitchen splashback): White tile (100x200mm) bevel edge

with midnight grout

Aluminium wardrobe

surrounds:

White

Exterior:



Interior:



Kitchen:





House position to be confirmed on Site Before work commences. Site plan based on Developers Site Plan.

Contractor to locate all service connections on site prior to earthworks, confirm all boundary setbacks & restrictions comply with current regulations prior to commencement of foundations. Any discrepancys within setbacks & FFL to contact Stonewood Homes immediately before commencement of any earthworks.



GENERAL NOTES

#Site Gross Aream²

Floor Area over Framing Floor Area over Foundation 172,50 m² Floor Area over Foundation (incl. Covered Areas) 175,25 m² Perimeter over Foundation 64,520.16

Site Coverage #Coverage% (40% Allowable) Impervious Surface Area 61.23m² (14.23% Excluding Dwelling & Garage)

Exposure Zone

Wind Zone High Earthquake Zone Snow Zone N4 1.0Kpa

Territorial Authority Selwyn District Council

Planning Zone

Concept subject to TA rules and regulations.

All dimensions to be confirmed on site

Concept may be subject to subdivision developer's approval

TC1 Firth Ribraft or TC2 Engineer Foundation Design Foundation Type:

Position of road crossing, services locations, street trees, lamp Site Information

posts, parking bays,pedestrian islands etc is unknown - to be confirmed when information becomes available.

This plan is indicative only.

Landscaping to be confirmed by the client.

All Fencing to comply with the relevant Covenants.


Confirmed with Certificate of Title **Boundary Information**

No Levels obtained Site Levels:

N/A Historical Interest: **Existing Use Rights:** N/A

Flood Management Area:

Non Compliances Requiring RC: N/A **Covenant Non Compliances:** N/A

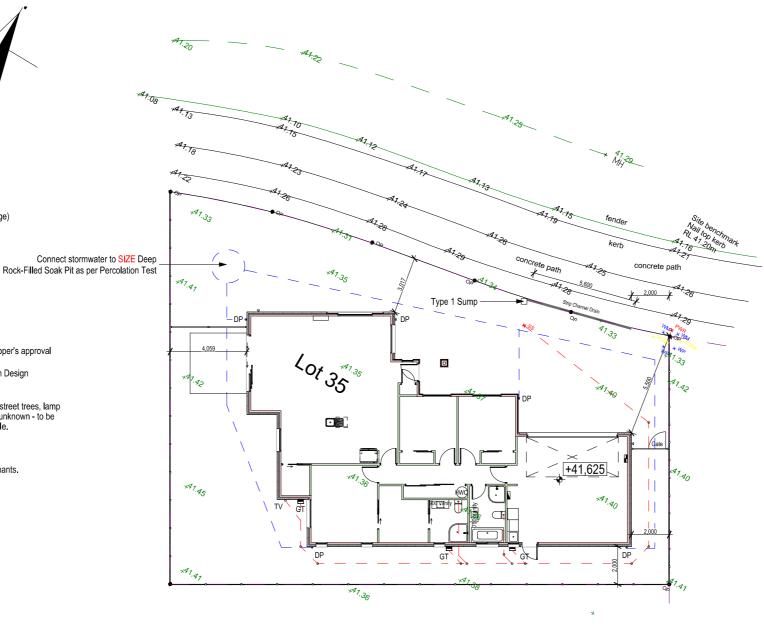

LEGEND

Ref	Fixture	Waste Size	Gradient
WC	Water Closet	80mm	1:60
В	Bath	40mm	1:40
SH	Shower	40mm	1:40
S	Kitchen Sink + DW	50mm	1:40
Van.U	Vanity Unit	40mm	1:40
WHB	Wash Hand Basin	40mm	1:40
TUB	Laundry Tub + WM	40mm	1:40
HWC	Hot Water Cylinder	20mm	1:400
WM	Washing Machine	Discharge to TUB	
GT	Gully Trap	ŭ	
RGT	Relief Gully Trap		
RP	Rodding Point		
TV	Terminal Vent	80mm	
BV	Branch Vent	40mm	
DP	Downpipe	75 x 50mm	
IP	Inspection Point		
AAV	Air Admittance Valve		
HT	Hose Tap		
HP	Heat Pump		
SS	Soil Stack	100mm	

100mm uPVC surface water drain at 1:100 gradient to laterals at boundary. (SW)

100mm uPVC foul water drain at 1:60 gradient to laterals at boundary. (SS)

General Note:

All plumbing and drainage to comply with Acceptable Solutions G13/AS/AS2 by qualifed tradesman. Allow to check all dimensions and falls of drains onsite prior to installation. Use 75x50mm downpipes. Contractor to locate all service connections on site prior to earthworks, confirm all boundary setbacks & restrictions comply with current regulations prior to commencement of foundations.

All waste pipes PVC. Sizes, fall, venting & discharge to be confirmed by NZ qualifed plumber. Confirm positions of available services cabling etc. on site prior to any excavation. Internal water pipes to be Polybutylene, All pipework & pipes exposed to freezing to be lagged with

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1:200

- Relief Gully Trap is to be positioned so that the top of the gully dish is no less than 150mm below the overflow level of the lowest sanitary fixture served by the drainage system.
- Position of drain connections at street laterals to be confirmed on site.
- Allow to thermally insulate all exterior pipework & valves exposed to external weather conditions.

Drain pipes discharging to GT:

- 25mm min air gap between all pipes & GT.

Site Plan 1.01

Landscaping

A Step/s or appropriate landscaping is to be provided if drop from external doors is greater than 190mm from FFL to FGL. All access routes must provide a non-slip surface in accordance to NZBC D1/AS Table 2. Convey surface water from sealed drive to an appropriate approved outfall.

STONEWOOD

PHONE: (03) 354 2344 I FAX: (03) 354 2322

ADDRESS: 99 Clarence Street

WEB: www.stonewood.co.nz

RW 2020 Limited

Site Plan

LEGAL DESCRIPTION:

NOTES: DATE OF ISSUE: DESIGNER: - Subject to council approval - All measurements to be confirmed on site by the contractor prior to the commencement of work

Michael TECHNICIAN: AMENDMENT DATE: Michael VERSION: CODE:

NOTE: THE SCHEDULE OF FIXTURES AND FITTINGS TAKES PRECEDENCE OVER THESE DRAWINGS

SCALE: 1:200 A1.01 JOB# 200077

DRAWING TITLE:

LOT: 35 DP The Link Rolleston

Raised ceiling

Raking ceiling

Internal Door Leaf Height Standard

Linings Gib Board 13mm Ceilings & 10mm walls.

Rondo Metal battens & 600crs Ceiling Battens Note: in High Wind Zone 2455mm stud height: studs @ 600mm centres

2605mm stud height: studs @ 400mm centres

N/A

N/A

Heating: Heat pump to be fixed in position shown on the drawings.

Refer to specifications for more information.

Bathroom & Ensuite to vent through soffit linings Ceiling Vents: Laundry to vent directly to exterior (unless opening window)

Range Hood to exit through soffit lining.

Smoke Alarms: Required within 3m of all sleeping areas, change in

level & entry/exits as per NZS 4514 & BRANZ Bulletins

N/A Extras:

FLOOR PLAN NOTES:


- All glazing to comply with NZS4223

- All hard floor finishes to comply with NZBC D1/AS Table 2. Floor tiles to be non-slip & have a slip coefficient value of 0.35 - 0.65 for grit finished ceramic tiles.

- Hot water pipes to be sized according to NZBC G12 & NZS4305:1996, Mains pressure: 15mm dia, allows 12mm max. pipe length. Pipe length beyond this must be lagged.
- Satin enamel wall finish to bathroom, ensuite & those walls adjacent to sinks etc, in kitchen & laundry, One row of tiles to be used above basins, vanities & benches. Bottom edge to be filled with fungus/mold resistant sealant.

WATER PROOFING MEMBRANE NOTE:

Wetseal waterproofing membrane required to tiled bathrooms with tiled rebated/level access showers.

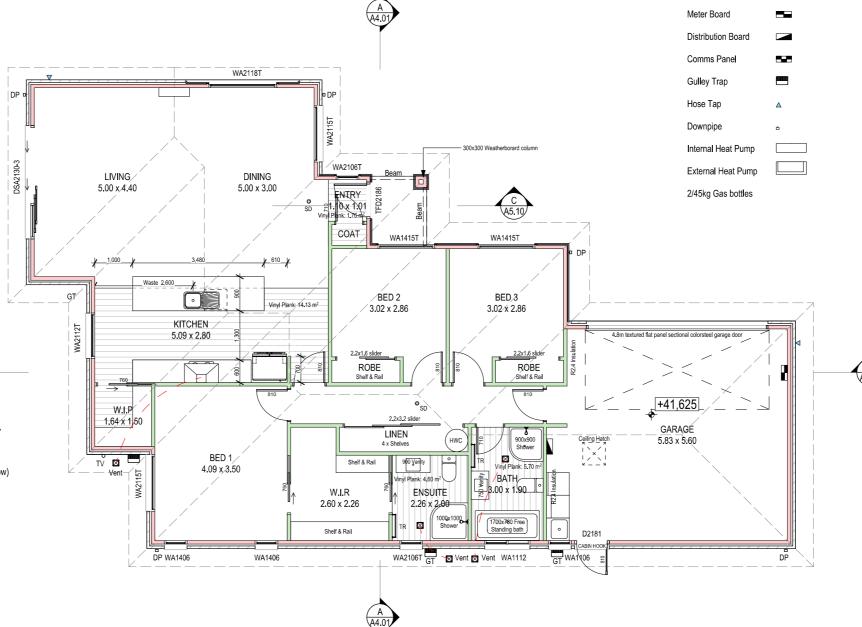

Ground Floor Plan

NOTE: THE SCHEDULE OF FIXTURES AND FITTINGS TAKES PRECEDENCE OVER THESE DRAWINGS

STONEWOOD

PHONE: (03) 354 2344 I FAX: (03) 354 2322

ADDRESS: 99 Clarence Street

WEB: www.stonewood.co.nz

JOB TITLE: **RW 2020** Limited

Ground Floor Plan

LEGAL DESCRIPTION: LOT: 35 DP

NOTES: - Subject to council approval - All measurements to be confirmed on site by the contractor prior to the commencement of work

1:100

DATE OF ISSUE: DESIGNER: SCALE: SHEET: Michael 1:100, 1:200 20/08/2020 TECHNICIAN: AMENDMENT DATE: Michael A2.01 JOB# VERSION: CODE: 200077

GENERAL FLOOR PLAN NOTES

Refer to Construction Schedule (Page 2 & 3 of Specification) for additional construction information.

Air Seals to have PEF rod & low expansion foam All windows and doors centered in room unless

WALL FRAMING - designed to high wind zone 2420 mm

Loadbearing wall: 90x45mm studs @ 600 mm crs

Non loadbearing: 90x45mm studs @ 600 mm crs

90x45 @ 800 crs

Lintels and beams can be found on the Truss Design

Watergate building wrap, refer to manufacturers

1980mm

RVG1 MDF

APL Latitude 860

90x45mm @ 800mm crs max

Everest (Vertical V groove)

Pink Batts Ultra R2.4 Wall Batts

Pink Batts R4.0 Ceiling Batts

(unless required for bracing)

Standard Aluminium Joinery

Dimond Metalline Quad Gutter

Dimond Metalline 185 Fascia

Colorsteel Rectangular 75x55mm

Hardiflex 4.5mm

Shelf and rail to wardrobes

13mm GIB Aqualine (bathrooms)

Standard 10mm GIB

Standard 13mm GIB

10mm GIB Aqualine

Square Stopped

INTERIOR AND EXTERIOR JOINERY
Joinery - Double Glazed Vantage

ROOF CLADDING AND STRUCTURE Battens - 50x50 SG8 H1.2 @ 300crs

GUTTER/FASCIA/DOWNPIPES/SOFFITS

Rheem 250L

MISCELLANEOUS:

shown otherwise

Stud Height:

Dwangs Int:

DOORS

Type:

Wall -

Ceilina -

Wall -

Ceiling -

Joinery -

Interior

Electric -

Electric Hob

Gutter -

Fascia -

Soffits -

Downpipes

Bathroom -

Corner Finish -

Ceiling Finish -

FLOOR FINISHES

WATER HEATING

KITCHEN COOKTOP

Carpet & Vinyl Plank

Internal Height:

Front Door:

INSULATION

KEY

Dimensions shown are to the frame, GIB thickness not shown.

Entry through external doors Mechanical ventilation

FOUNDATION SYSTEM

Foundation Firth Ribraft

Exterior & Interior 2455mm

LINTELS AND BEAMS

specifications attached

WALLAND CEILING LININGS

BUILDING WRAP

The Link Rolleston

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GENERAL NOTES:

Floor area over framing:

Insulation: R2.4 Exterior walls (+ interior garage walls)

R4.0 Ceiling (excluding garage)

Typical stud height: 2455mm to underside of truss, 90x45mm SG8

@ 600mm crs max, in High wind zone.

Window lintel height: 2125mm

Standard, unless noted otherwise Internal door leaf height:

(OH = Overheight)

All exterior window & door lintels by truss General:

manufacturer. Internal nonloadbearing walls to be SG8 graded.

All dimensions to be confirmed on site.

FIXING SCHEDULE:

JOINT: FIXING:

Exterior Bottom plate to concrete floor (Non-braced): Lumberlok Bottom Plate Anchors with

75x4mm dia. concrete nails adjacent to anchor 70mm min from edge of slab. as per manufacturers specifications. @ 900mm crs. max as per NZS3604:2011. Refer to bracing plan for additional

hold down fixings.

75 x 8mm shot fired fastenings with Interior bottom plate to concrete floor:

16mm washers @ 600mm crs, within 150mm each end of plate. Refer to bracing plan for additional

100 x 3.75mm nails @ 600mm crs

hold down fixings. Stud to Bottom or Top plate:

2/90 x 3.15 end nails + 2/wiredogs (Or

Alternative 4.7kN Fixings). 2/100 x 3.15mm skewed nails Dwang to stud: Fish plate to Straightened stud: 4/60 x 2.8mm nails each side Half Joint in top Plate: 4/100 x 3.15mm skewed nails 4/100 x 3.15mm skewed nails Lintel to trimming Stud:

Standard soffit stringer to stud: 2/100 x 3.75mm nails Sill trimmer to trimming stud for:

- Trimmer not exceeding 2400mm 2/100 x 3.75mm end nails - Trimmer not exceeding 3000mm 3/100 x 3.75mm end nails - Trmmer not exceeding 3600mm 4/100x3.75mm end nails Double top plate to top plate: 2/100 x 3.75mm @ 500mm crs

Trimming studs together at openings, Studs & blocking at wall intersections: Trimming Stud to Doubling Stud immediately

under lintels:

2/100 x 3.75mm nails Trusses to Top Plate: Refer to truss design (Or 2/90mm x 3.15mm skew nails plus 2/wiredogs. (Alt.

fixing 4.7Kn)

Ceiling battens to Truss bottom chord: 2/75 x 3.15mm nails @ 400mm crs Outrigger to Gable Top Plate: 1/14g self drilling screw, 150mm long 2/100 x 3.75mm end nails Outrigger to Truss: Flying Rafter to Outrigger: 2/100 x 3.75mm end nails

Outrigger Blocking to Top Plate: 4/100 x 3.75mm skewed nails 1/10g self drilling screw, 80mm long

SCHEDULE OF FRAMING TIMBERS - GRADING AND TREATMENT

Wall framing

Exterior walls & lintels SG8, H1,2, Pinus radiata SG8, H1,2, Pinus radiata Interior walls (loadbearing) SG8, H1.2, Pinus radiata Interior walls (non-loadbearing) Wet Area Bottom plates & Framing SG8, H1.2, Pinus radiata

Cavity battens:


SG8, H3,2, Pinus radiata -Dry Cavity -Wet Cavity SG8, H3.2, Pinus radiata


Roof framing


SG8, H1,2, Pinus radiata Roof trusses - typical Gable end truss SG8, H1,2, Pinus radiata SG8, H1.2, Pinus radiata Coved or attic trusses SG8, H1.2, Pinus radiata Purlins/Battens SG8, H3.2, Pinus radiata Valley boards, barge boards

Windows

Dressed, H3,1, Pinus radiata Framing and reveals

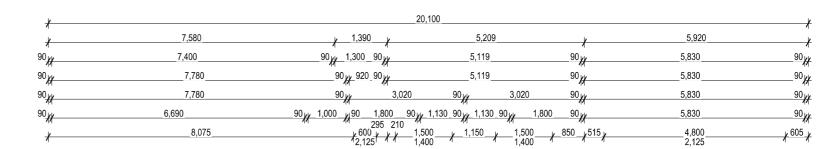

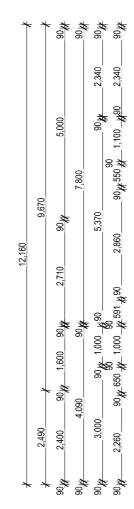

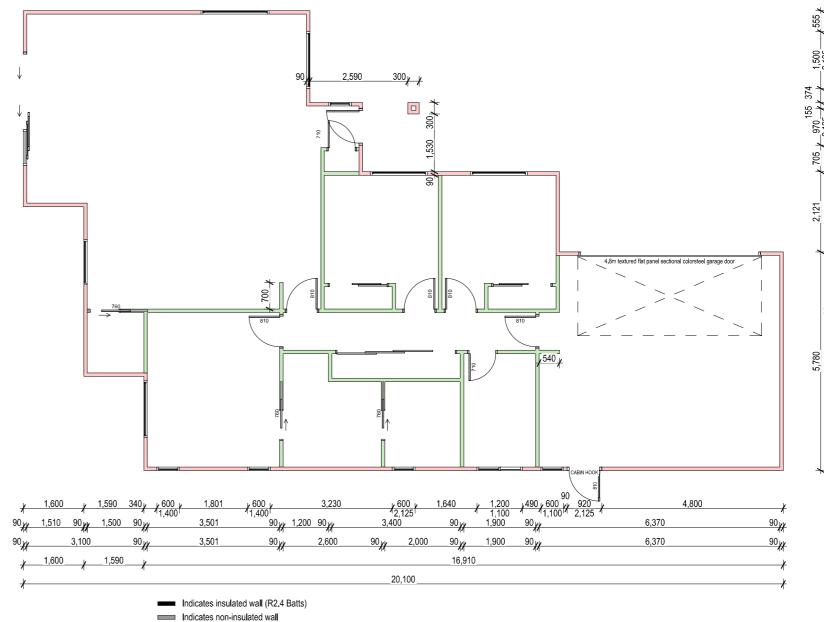

Ground Floor Framing Plan SCALE 1:100 @A3

Sizing of timber plates

Bottom Plate 45mm thick, width to match stud. SG8, H1.2, Pinus Radiata Top Plate 45mm thick, width to match stud. Additional top plate 35mm thick, 90mm wide if 90mm wall, 140mm wide if 140mm wall. SG8, H1.2, Pinus Radiata

All tiled areas to have dwangs @ 600mm crs. max. (Excludes skirting/upstands)

Indicates insulated interior wall (R2.4 Batts) Indicates Aqualine/Wetarea lined wall

> Plumbing fixtures shown to indicate wet areas. GIB e/Wetarea Lining to all wet areas as standard

> > Rolleston

NOTE: THE SCHEDULE OF FIXTURES AND FITTINGS TAKES PRECEDENCE OVER THESE DRAWINGS

STONEWOOD

PHONE: (03) 354 2344 | I | |
ADDRESS: 99 Clarence Street
WEB: www.stonewood.co.

JOB TITLE: **RW 2020** Limited

DRAWING TITLE: Framing Plan LEGAL DESCRIPTION: LOT: 35 DP: The Link

NOTES: DATE OF ISSUE: DESIGNER: Michael - Subject to council approval

20/08/2020 - All measurements to be confirmed on site by TECHNICIAN the contractor prior to the commencement of work AMENDMENT DATE: Michael All rights reserved. No part of this work covered by copyright may be reproduced or copied in any form or by any means without the written permission of Stonewood Homes. VERSION: CODE: #Amendment Date

SCALE: :100 A2.02 JOB# 200077

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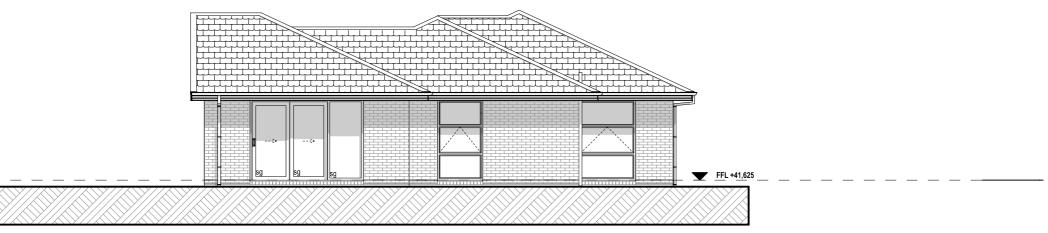
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GENERAL NOTES

Foundation Type Wall Cladding Materials Roofing Materials

Roof Pitch **Eaves Width**

General:

Eaves width Medium risk Envelope complexity Low Deck design Low Total Risk Score:

Wind zone (per NZS 3604) Number of storeys

Roof/wall intersection design

BUILDING ENVELOPE RISK MATRIX North Elevation

TC1 Firth Ribraft

NOTE: Glazing & glazed openings to comply with NZS4223,3:2016 Glazing in buildings - Part 3: Human impact safety requirements, NZS4211:2008: Specification for performance of windows & New Zealand building Code Clauses: F2 Hazardous materials.

Low risk

Metal tile 25deg 600 &450 Gable

Brick veneer & Hardies weatherboard (Smooth)

Concept subject to TA rules & regulations. Concept subject to subdivision developer's approval.


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2

All dimensions to be confirmed on site.

All exterior window & door lintels by truss manufacturer.

North Elevation 1:100

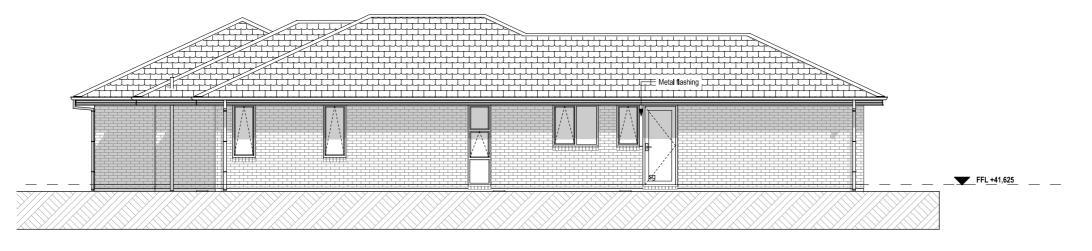

BUILDING ENVELOR	E RISK MATR	IX
South Ele	vation	
Risk Factor	Risk Severity	Risk Score
Wind zone (per NZS 3604)	High risk	1
Number of storeys	Low risk	0
Roof/wall intersection design	Low	0
Eaves width	Medium risk	1
Envelope complexity	Low	0
Deck design	Low	0
Total Risk Score:		2

West Elevation 1:100



PHONE: (03) 354 2344 | FAX: (03) 354 2322
ADDRESS: 99 Clarence Street
WEB: www.stonewood.co.nz

JOB TITLE: **RW 2020** Limited

DRAWING TITLE: **Elevations** LEGAL DESCRIPTION: LOT: 35 DP: The Link


Rolleston

NOTES: DATE OF ISSUE: Subject to council approval
 All measurements to be confirmed on site by
the contractor prior to the commencement of work 20/08/2020


DESIGNER: SCALE: Michael 1:100 TECHNICIAN: AMENDMENT DATE: Michael JOB# All rights reserved. No part of this work covered by copyright may be reproduced or copied in any form or by any means without the written permission of Stonewood Homes. VERSION: CODE: #Amendment Date

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A3.01 200077

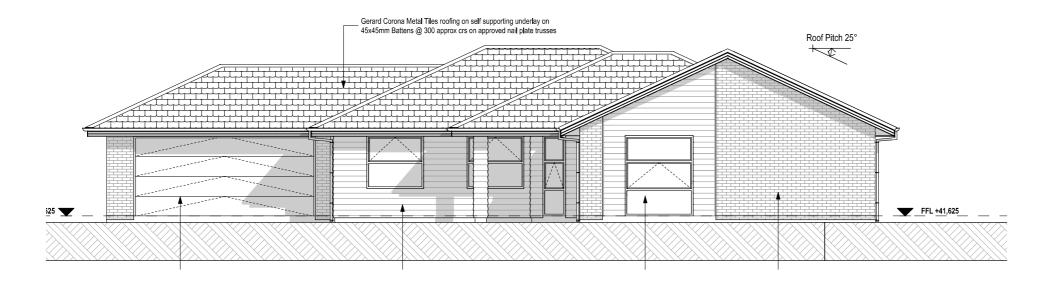

East Elevation

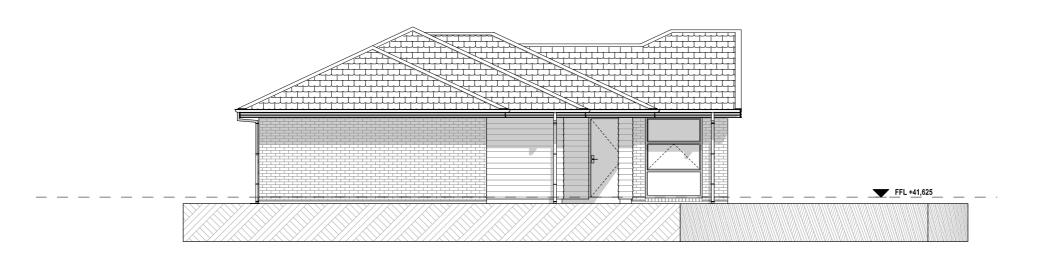

South Elevation 1:100

STONEWOODHOMES

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JOB TITLE: **RW 2020** Limited

DRAWING TITLE: **Elevations**

LOT: 35 DP: The Link Rolleston

LEGAL DESCRIPTION:

1:100

NOTES: DATE OF ISSUE: DESIGNER: Subject to council approval
 All measurements to be confirmed on site by
the contractor prior to the commencement of work Michael 20/08/2020

Total Risk Score:

SCALE: 1:100 TECHNICIAN: AMENDMENT DATE: Michael A3.02 JOB# All rights reserved. No part of this work covered by copyright may be reproduced or copied in any form or by any means without the written permission of Stonewood Homes. VERSION: CODE: 200077

#Amendment Date

BUILDING ENVELOPE RISK MATRIX West Elevation Risk Factor Risk Severity Risk Score Wind zone (per NZS 3604) High risk Number of storeys Roof/wall intersection design Low Eaves width Medium risk Envelope complexity Low Deck design Low

GENERAL NOTES

Risk Factor

Eaves width

Deck design

Total Risk Score:

Wind zone (per NZS 3604)

Roof/wall intersection design

Number of storeys

Envelope complexity

TC1 Firth Ribraft

600 & 450 Gable

NOTE: Glazing & glazed openings to comply with NZS4223,3:2016 Glazing in buildings - Part 3: Human impact safety requirements, NZS4211:2008: Specification for performance of windows & New Zealand building Code Clauses: F2 Hazardous materials.

Risk Severity Risk Score

0

0

High risk

Low risk

Low

Low

Low

Metal tile

25deg

BUILDING ENVELOPE RISK MATRIX East Elevation

Brick veneer & Hardies weatherboard (Smooth)

Concept subject to TA rules & regulations. Concept subject to subdivision developer's approval. All dimensions to be confirmed on site.

All exterior window & door lintels by truss manufacturer.

Foundation Type
Wall Cladding Materials

Roofing Materials


Roof Pitch

General:


Eaves Width

NOTE: THE SCHEDULE OF FIXTURES AND FITTINGS TAKES PRECEDENCE OVER THESE DRAWINGS


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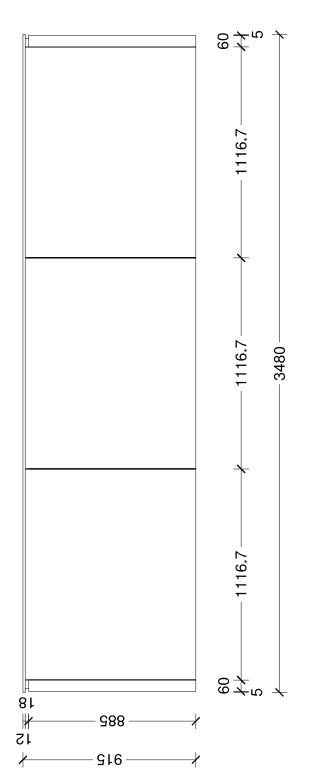

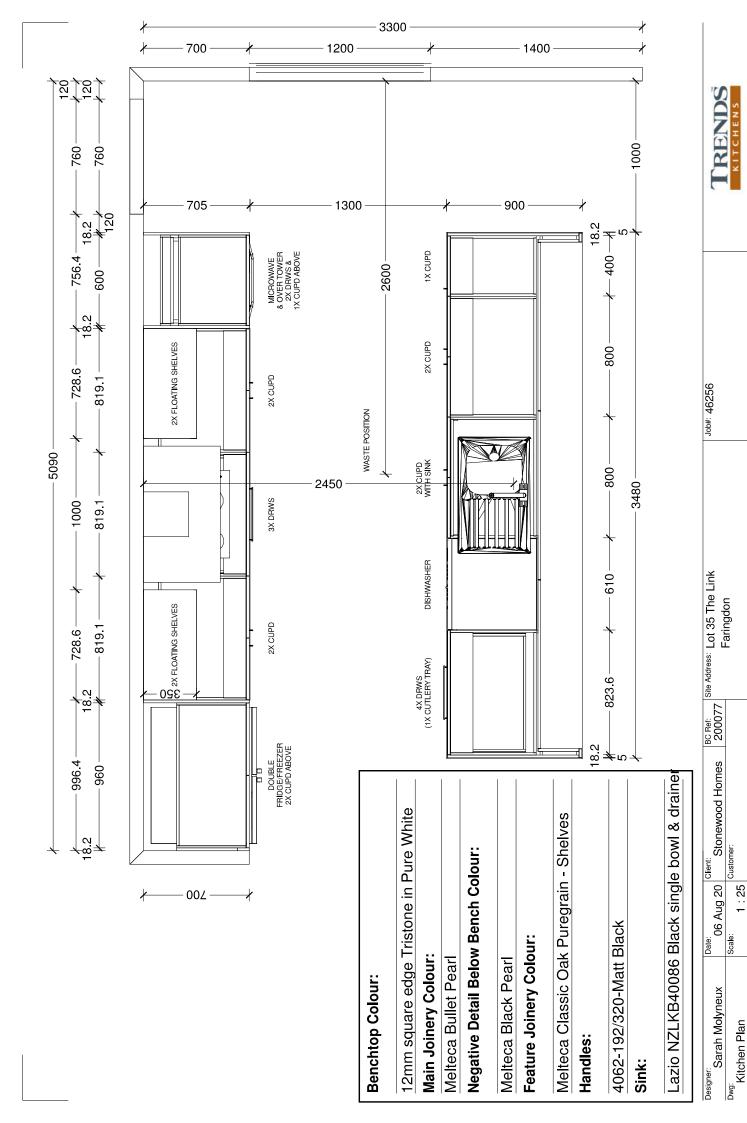
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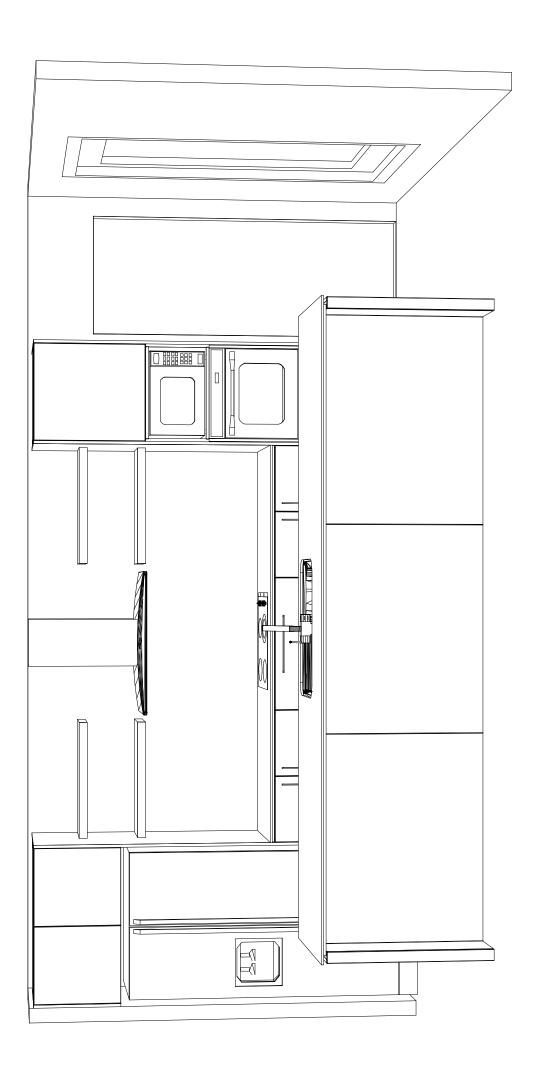


Designer: Sarah Molyneux	Date: Client: 06 Aug 20	Client: Stonewood Homes	BC Ref. Site Address: Lot 35 The Link 200077	Job#: 46256	TRENDS
Dwg: Kitchen Elevation	Scale: 0	Customer:	raiigaoi		KITCHENS
This is an original design and n	must not be released	ל or copied unless applicab	This is an original design and must not be released or copied unless applicable fee has been paid or job order placed. All dimensions and size	imensions and size designations given are subject to verification on job site and adjustment	tion on job site and adjustment to fit job conditions.

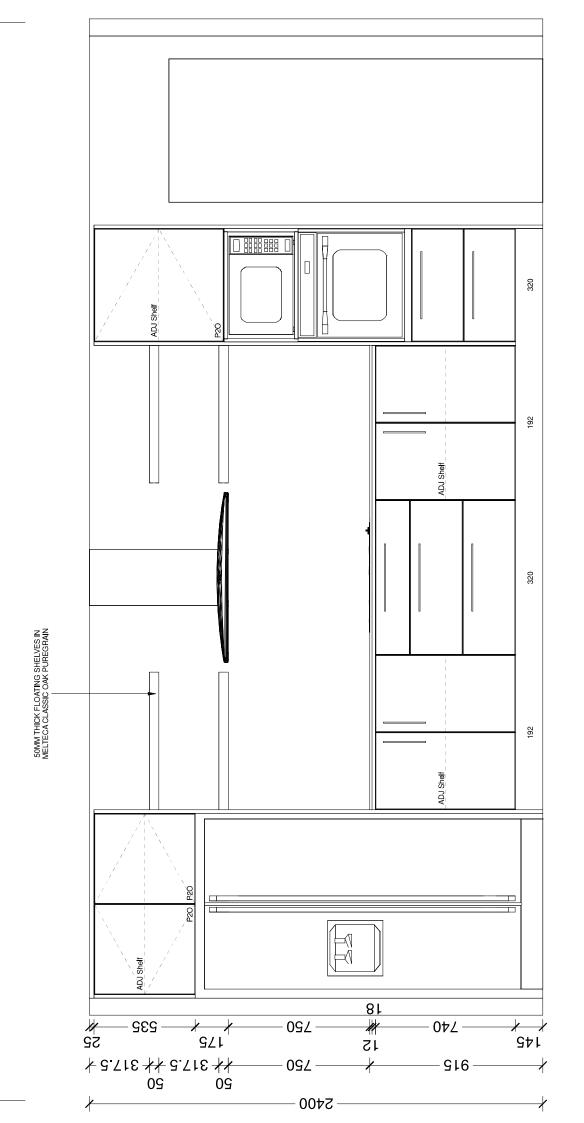


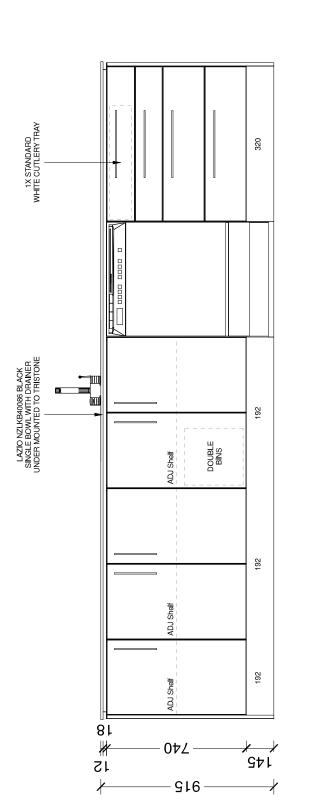


Designer: Sarah Molyneux	Date: 06 Aug 20	Client: Stonewood Homes	BC Ref: 200077	Site Address:	Job#: 46256	TRENDS
Dwg: Kitchen Elevation	Scale:	Customer:		raringdon		KITCHENS
This is an original design and must not be released or copied unless applicable fee has been paid or job order	must not be release	ed or copied unless applicab	ole fee has	been paid or job order placed. All dimensions and size	designations given are subject to verificatio	n on job site and adjustment to fit job conditions.




Designer: Sarah Molyneux	Date: Client: 06 Aug 20	Client: Stonewood Homes	BC Ref: S	BC Ref: Site Address: Lot 35 The Link 200077	Job#: 46256	TRENDS
Dwg: Kitchen 3D Perspective	Scale:	Customer:		- d = 1900		KITCHENS
This is an original design and must not be released or copied unless applicable fee has been paid or job order	ust not be releas	sed or copied unless applical	ble fee has b	placed. All dimensio	ns and size designations given are subject to verificati	ication on job site and adjustment to fit job conditions.

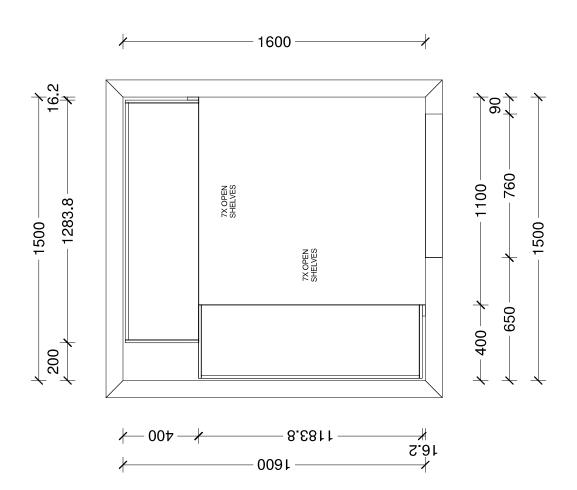


Designer: Sarah Molyneux	Date: Client: Client Stonewood Homes	BC Ref: Site Address: Lot 35 The Link 200077	Job#: 46256	TRENDS
_{Dwg:} Pantry Plan	Scale: Customer:	raiiigaoi		KITCHENS
This is an original design and r	his is an original design and must not be released or copied unless applicable fee has been paid or job order	e fee has been paid or job order placed. All dimensions and size c	lesignations given are subject to verificat	ion on job site and adjustment to fit job conditions.

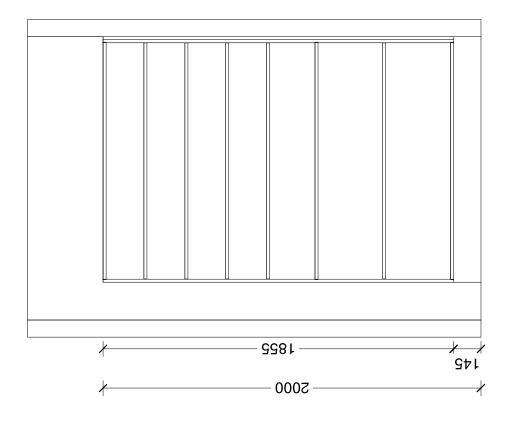

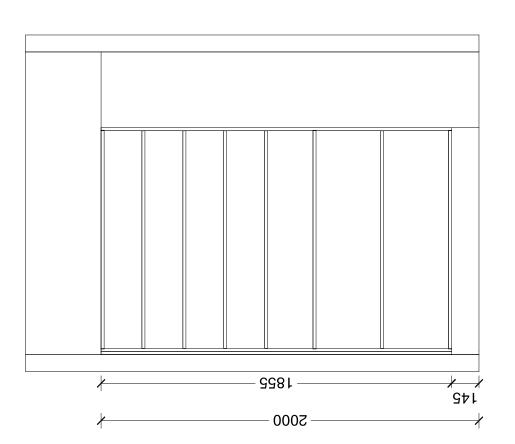

Designer: Sarah Molyneux	Date: 31 Jul 20	Client: Stonewood Homes	BC Ref: Site Address: Lot 35 The 200077	ot 35 The Link	Job#: 46256	TRENDS
Dwg: Pantry Elevation	Scale: 1 : 20	Customer:		רמוויטעטיי		KITCHENS
This is an original design and must not be released or copied unless applicable fee has been paid or job order	nust not be releas	sed or copied unless applica	ble fee has been paid or	job order placed. All dimensions and size design	lesignations given are subject to verificatior	on job site and adjustment to fit job conditions.

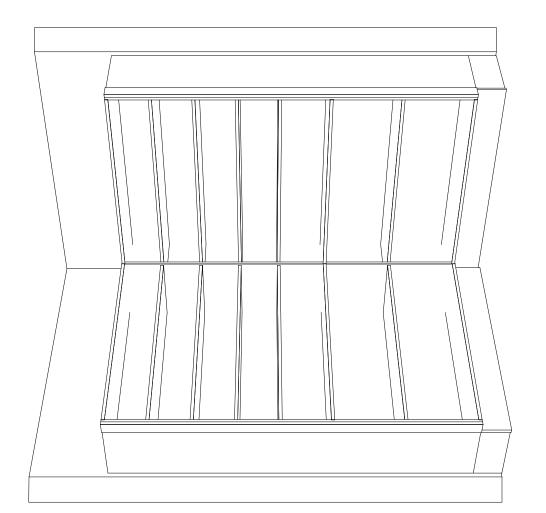

_{Designer:} Sarah Molyneux	Date: 31 Jul 20	Client: Stonewood Homes	BC Ref: Site Address: Lot 35 The Link 200077	Job#: 46256	TRENDS
Dwg: Pantry 3D Perspective	Scale:	Customer:	Faringdon		KITCHENS
This is an original design and m	ust not be releas	sed or copied unless applicat	This is an original design and must not be released or copied unless applicable fee has been paid or job order placed. All dimensions an	nd size designations given are subject to verific	ation on job site and adjustment to fit job conditions.



SMART SYSTEMS


Lot 35 The Link


Rolleston, Christchurch

Tower Junction Christchurch

Web: smartsystems.net.nz info@smartsystems.net.nz Email:

Drawing Not To Scale

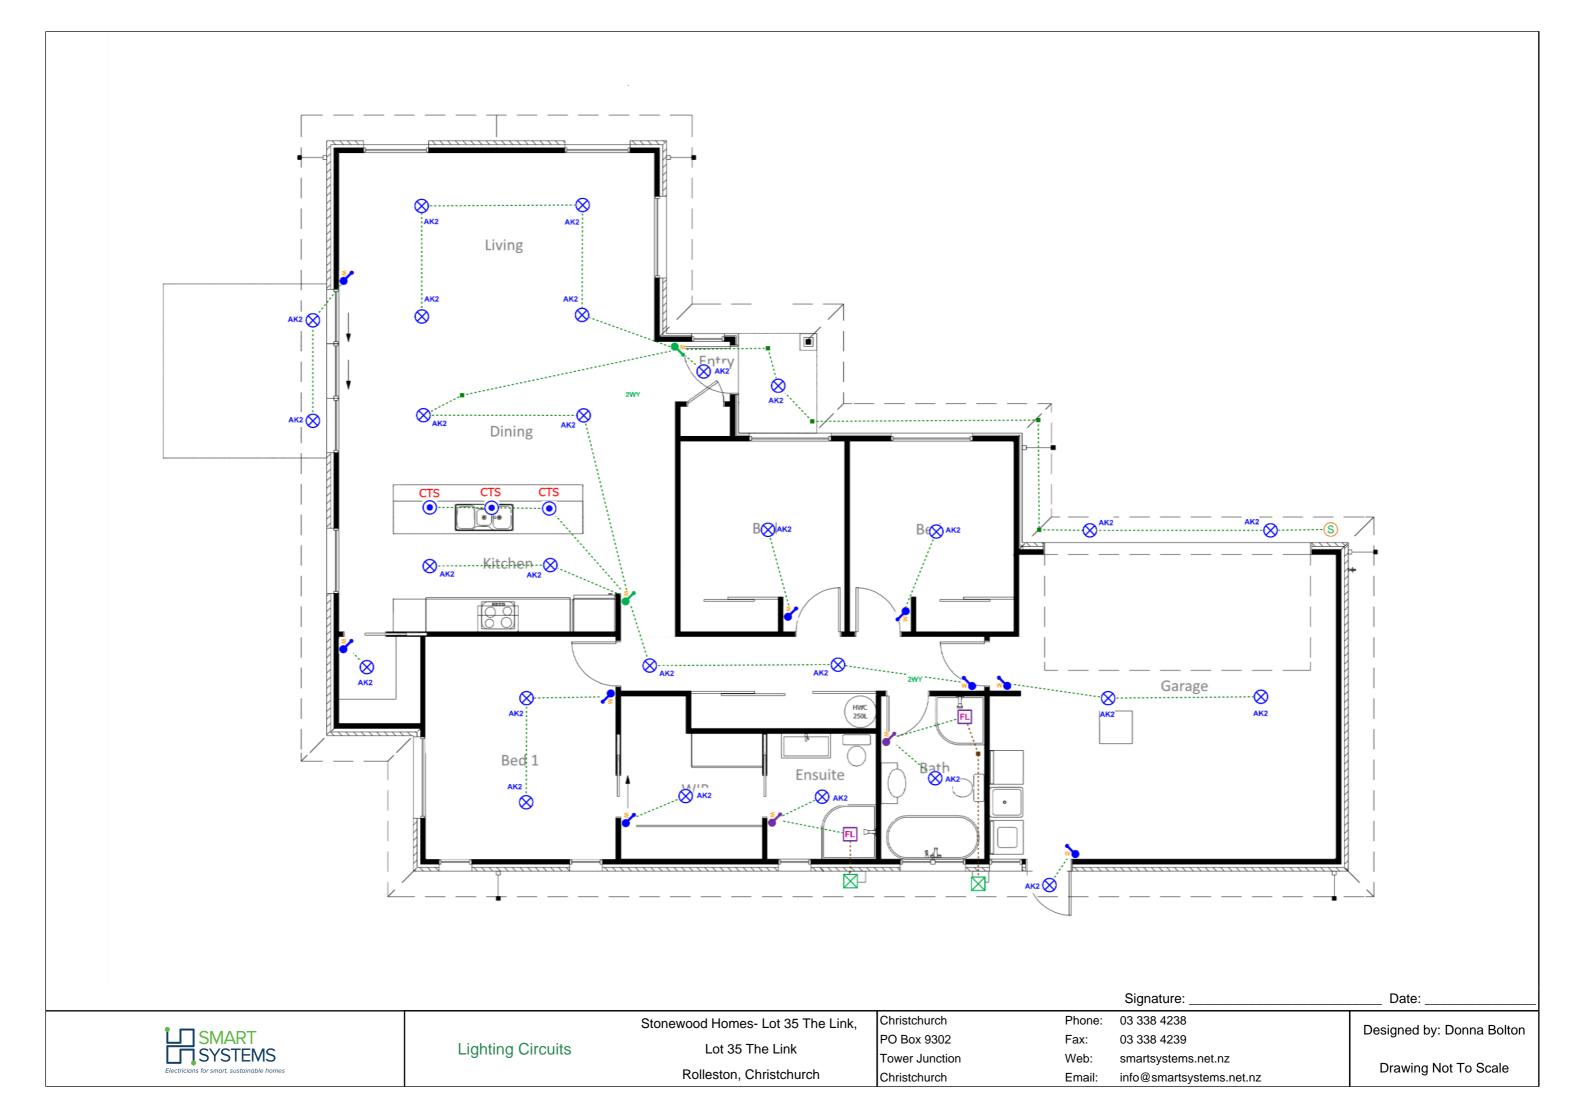

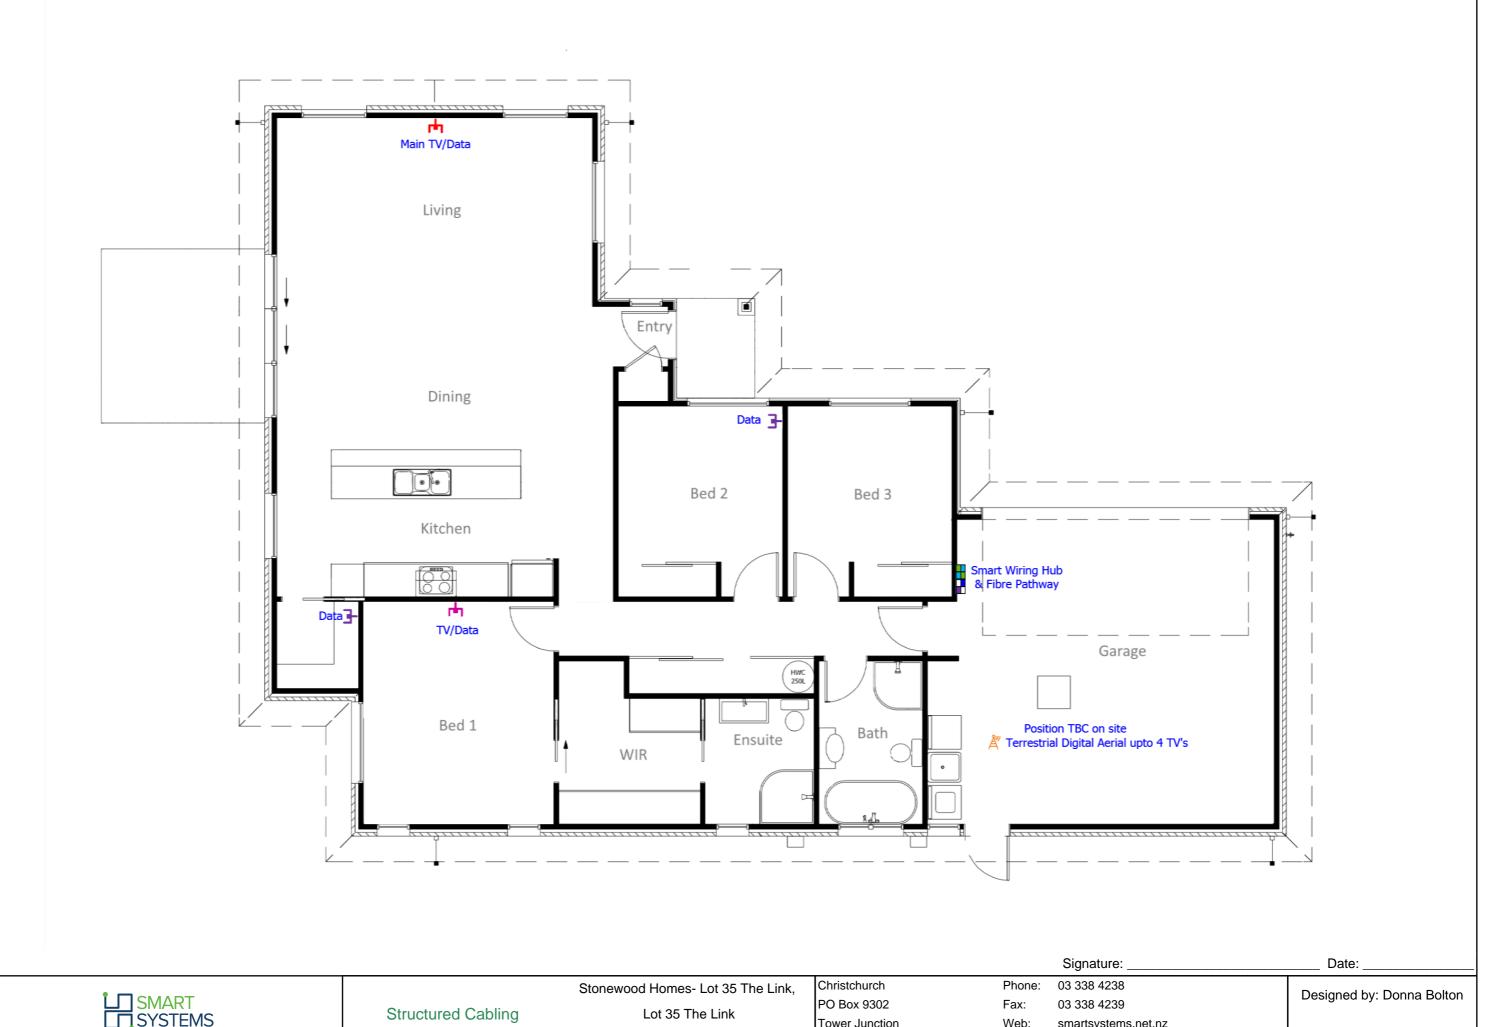

Rolleston, Christchurch

SMART SYSTEMS

Tower Junction Christchurch

Web: smartsystems.net.nz info@smartsystems.net.nz

Drawing Not To Scale

Key & Specification

Date 27/07/2020



To

Stonewood Homes- Lot 35 The Link

Site Address

Lot 35 The Link Faringdon

Job No 2109 Customer ID 106465 Building Co Order Sales Person Donna Bolton

Class	Job Description	Quantity
Electrical Power:		
EP011001	Electrical Base for 30 way switchboard	1
₩ EP025121	Internal flush mounted meter box Please Note: meter box mounted directty above the ducts for the mains cable on the internal side of the wall. No allowance to move meter box for bracing.	1
♥ EP100082	Rangehood plug socket (no switch) white	1
♀ EP100110	Smart wiring power sockets for hub white	1
₩ EP141001	Voltex classis single power socket 10A white	2
₩ EP141021	Voltex classic double power socket horizontal white 10A	21
₩ EP141071	Voltex classic garage door sinlge power socket and press switch 10A white	1
₩ EP141111	Voltex classic single power socket for dishwasher 10A white	1
₩ EP141151	Voltex classic built in oven conenction & isolation switch max 20m from switchboard & up to 20A max	1
₩ EP141161	Voltex classic electric hob connection & isolation switch up to 20m from switchboard & 32A max	1
₩ EP141221	Voltex classic hot water cylinder connection standard tarrif white	1
₩ EP142021	Voltex classic double power socket 10A black	1
Ф EP210001	Air conditioning outside unit power and isolation switch 16A max single phase	1
S EP220001	Smoke detector mains powered with 9V battery backup	2
C EP222501	Capping for sockets and/or switches in joinery	1
Lighting Circuits: S EL006001	External 190 degree movement concer white	1
S EL006001 EL110034	External 180 degree movement sensor white	1 27
_	Recessed light circuit	
EL110035EL110201	Pendant light circuit 2 way light circuit	3
EL130501	Voltex classic 1-gang light switch white	9
EL130510	Voltex classic 3-gang light switch white	2
EL130515	Voltex classic 4-gang light switch white	2
FL EL180008	Extractor fan/light circuit & install only Please note: fan/light not included	2

Structured Cabling:

SC001111	Smart wiring base 12 data sockets 20" hub	1
SC050005	Fibre optic ducted pathway to external demarcation point	1
SC120151	Voltex classic Cat6 data socket 1Gb/s white	2
└ SC240701	Voltex classic TV/data socket cat6 1Gb/s white	1
₩ SC240801	Voltex classic main TV & data socket cat6 1Gb/s white	1
്ക് SC402001	Digital terrestrial aerial suitable for Freeview HD up to 4 TV outlets	1

Please note: Freeview HD reception requires line of sight to the transmitter and signal levels and quality can not be confirmed until a site visit is completed. Any further hardware or upgrade of aerial materials not included in quote.